Zip:

Telephone:

FLORIDA DEPARTMENT OF TRANSPORTATION

UTILITY PERMIT

PERMIT NO: 2019-H-294-01023

STATE ROAD INFORMATION

County:	Section:	State Road No:	Beginning Mile Post:	Ending Mile Post:
Duval	72160448	SR 13	0.950	0.950

APPLICANT INFORMATION

Builder make a join	t permit applicant, as prescribed in Section 2.1(4)	of the 2017 Utility Accommodati	O is a City or County and desires to have the Utility on Manual (UAM), the Utility Builder shall also be
applicant.	phicant Information Box. A Utility Builder alone	cannot apply for a utility permit	without the City or County adding them as a joint
	Utility Agency/Owner (UAO)	Utility Builder (only	applicable when the UAO is a City or County)
Name:	Jacksonville Transportation Authority	Name:	
Contact Person: Jacksonville Transportation Authority Contact Person: JOSEPH MANG		JOSEPH MANGELS	
Address:	121 West Forsythe St	Address:	
City:	Jacksonville	City:	
State:	Florida	State:	

WORK DESCRIPTION

The Applicant(s) requests permission from the Florida Department of Transportation (FDOT) to construct, operate, and maintain the utilities as described
below and as depicted in the incorporated documentation.
Miller Electric Company intends to completely replace the decorative lighting
system that is located on and spans the entire
length of the Acosta Bridge. This process will be broken into two primary phases.
The first phase will be to completely demo
and dispose of the existing Neon fixtures along with its corresponding parts
(conductors, connectors, drivers, etc.). The
majority of the existing conduit infrastructure will remain in tact (see plans).
The second by 111 by 11
This Work No:
Additional sheets are attached and are incorporated into this permit Yes W No
Additional sheets are attached and are incorporated into this perint. Tes 🗾 No 🗌
For FDEP certification, the FDOT agency report is attached in accordance with UAM Section 2.4.1 (13) Yes 🔲 No 🗹

TRAFFIC CONTROL (TCP)

■ The TCP will comply with the following 600 seri	es index(es) _6	619		
☐ A TCP has been attached and incorporated into this permit application in compliance with UAM Section 2.4.2.				
MOT Technician's contact information (may be supp	alied at the two	o (2) business day notification to FD0)T)·	
Name: Seun Falade	Telephone	(050) 070 0004	Email:	seun@cornerstonebarricades.com

COMMENCEMENT OF WORK

The UAO and/or Utility Builder shall commence actual construction in good faith within sixty (60) calendar days after approval of the permit application. If the beginning date is more than sixty (60) calendar days from the date of approval, the UAO and/or Utility Builder must review the permit with the FDOT Approving Engineer listed to make sure no changes have occurred to the transportation facility that would affect the permit's continued approval. The UAO and/or Utility Builder shall make good faith efforts to expedite the work and complete the work within the calendar days indicated.

Anticipated Start Date:	1/13/2	020
Calendar days needed to	completed:	255

Florida Department of Transportation

UTILITY PERMIT

PERMIT NO: 2019-H-294-01023

APPLICANT SIGNATURE

By the below signature(s) the UAO and/or Utility Builder agree(s) to construct, operate, and maintain the work as noted in the above Work Description, shown in plans and incorporated documents, in compliance with the UAM, all instructions noted in the FDOT Special Instructions Box, and special instructions incorporated into this permit. The UAO and/or Utility Builder declares, the location of all existing utilities that it owns or has an interest in, both aerial and underground, are accurately shown on the plans of the work areas. In accordance with UAM Section 2.8, the UAO and/or Utility Builder further declares that a letter of notification was delivered to the owners of other facilities within the work great and that those listed below are the only facility

	to be involved or potentially impacted by the proposed work.		
Date Notified:	Name of other facility owners (attach additional sheets if necessary).		
7/9/2019	Jacksonville Transportation Aut	nority	
7/9/2019	City Of Jacksonville	City Of Jacksonville	
1/3/2020	ATT/Transmission		
1/3/2020	CenturyLink		
1/3/2020	ATT/Distribution		
Utility Agency/Owner		Utility Builder (when applicable)	
Signature: ANGIE WILLIAMS (digital signature) Name (printed): ANGIE WILLIAMS Title:		Signature: JOSEPH MANGELS (digital signature) Date: 12/30/2019 Name (printed): JOSEPH MANGELS Title:	

FDOT PROJECT INFORMATION

Pursuant to UAM Section 2.1(10), the utility work is within FDOT projects listed below and must have a Utility Work Schedule for each project approved prior to commencement of work within the FDOT project limits:
There are NO FDOT constructions (proposed or underway).

This work is NOT related to an approved Utility Work Schedule.

FDOT SPECIAL INSTRUCTIONS

In accordance with UAM Section 2.7, FDOT incorporates the below and attached special instructions into this permit.

Contact Richard Harvey, Maintenance Manager Permits at (904) 360-5462, a minimum of two (2) business days prior to starting work within FDOT Right of Way to schedule a pre-construction meeting. Be advised that a pre-construction meeting must be held with an FDOT inspector prior to any work commencing within FDOT Right of Way. Contact Brian Kirts, Project Administrator at (904) 360-5556, a minimum of two (2) business days prior to starting work to prevent ... (see special instructions cont. page)

Additional FDOT Special Instructions are attached and incorporated into this permit. Yes \(\subseteq \) No \(\subseteq \)

PERMIT APPROVAL

By signature below, FDOT gives permission to the UAO and /or Utility Builder to construct, operate, and maintain the utilities indicated in this Utility Permit in compliance with the UAM, all incorporated documents, and special instructions. Any changes to the approved work must be approved by the FDOT's Approving Engineer and attached and incorporated into this permit in accordance with UAM Section 2.11. Approving Engineer: Julian Mckinley (digital signature) Date: 6/3/2020 Name: Julian Mckinley Title: MAINTENANCE PROGRAM ENGINEER Notification of Utility Work to be provided to: Telephone (904) 360-5462 ext. _ Email: richard.harvey@dot.state.fl.us

		An FDOT Representative is re	equired to be present on th	ne worksite prior to co	ommencement of work. Yes	No
Ren. Name:	Richard Harvey		9043605462	_	richard.harvey@dot.state.	

Florida Department of Transportation

UTILITY PERMIT

PERMIT NO: 2019-H-294-01023

CERTIFICATION

	documents, and special instructions. Pursuar	nt to UAM Section 2.11, all change	es have been approved by t	ected in compliance with the UAM all incorporated the FDOT's Approving Engineer and incorporated as-built plans or other required documentation.
	I also CERTIFY that work began on3/5 than when the work began.	9/2020 and was completed or	n and t	that the area was left in as good or better condition
	Utility Agency/O	Owner	Util	lity Builder (when applicable)
	Signature:	_ Date	Signature:	Date
	Name (printed):		Name (printed):	
	Title:		Title:	
	The work was inspected and found to	FINAL INSPECT be in non-compliance as noted belo		
	UAO and/or Utility Builder. However, to Rule 14-46.001, the UAM, all income	this final inspection does not relear rporated documents, and special ins	se the UAO and/or Utility Estructions.	outstanding issues that need to be addressed by the Builder of their continuing responsibilities pursuant
	FDOT Inspector:			
	Name:			
ı	I IIIe.			

PERMIT NO.: 2019-H-294-01023	
The complete Work Description could not fit in the space allotted on Page 1 of the Utility Permit so it is displayed below.	
Work Description	
Miller Electric Company intends to completely replace the decorative lighting system that is located on and spans the entire length of the Acosta Bridge. This process will be broken into two primary phases. The first phase will be to completely demo and dispose of the existing Neon fixtures along with its corresponding parts (conductors, connectors, drivers, etc.). The majority of the existing conduit infrastructure will remain in tact (see plans). The second phase will be to install all of the new LED fixtures, devices, conductors, equipment, etc., as well as test/troubleshoot the new system. With this scope of work, the inside lane and shoulder will need to be closed, along with the appropriate direction of Skyway vehicle. There will be no construction to the bridge structure itself or directional drilling	

PERMIT NO.: 2019-H-294-01023
STATE ROAD INFORMATION: Duval SR 13, Section: 72160448, Begin MP: 0.950, End MP: 0.950, Duval SR 13, Section: 72160006, Begin MP: 0.102, End MP: 0.102, Duval SR 13, Section: 72160448, Begin MP: 0.950, End MP: 0.950, Duval SR 13, Section: 72160008, Begin MP: 0.099, End MP: 0.099, Duval SR 13, Section: 72160448, Begin MP: 0.706, End MP: 0.706, Duval SR 13, Section: 72160006, Begin MP: 0.102, End MP: 0.102, Duval SR 13, Section: 72160448, Begin MP: 0.706, End MP: 0.706, Duval SR 13, Section: 72160448, Begin MP: 0.950, End MP: 0.950
NAME OF OTHER FACILITY OWNERS / DATE NOTIFIED:
FDOT PROJECT INFORMATION: There are NO FDOT constructions (proposed or underway). This work is NOT related to an approved Utility Work Schedule.
THE WORK WAS INSPECTED AND FOUND TO BE IN NON-COMPLIANCE AS NOTED BELOW:

PERMIT NO.: 2019-H-294-01023

The complete special instructions could not fit in the space allotted on Page 2 of the Utility Permit so they are displayed below.

Special FDOT Instructions

Contact Richard Harvey, Maintenance Manager Permits at (904) 360-5462, a minimum of two (2) business days prior to starting work within FDOT Right of Way to schedule a pre-construction meeting. Be advised that a pre-construction meeting must be held with an FDOT inspector prior to any work commencing within FDOT Right of Way. Contact Brian Kirts, Project Administrator at (904) 360-5556, a minimum of two (2) business days prior to starting work to prevent MOT conflicts. Provide as built plans after permit project completion.

Any disturbed areas will be restored with sod or like material immediately.

Any disturbed sidewalk will be restored to current standards in original or better condition within 24 hours.

Any lane closure request will require 2 weeks' notice for approval and may be restricted to night work only.

No Hay Bales for erosion or sedimentation controls are allowed in the FDOT Right of Way.

This permit covers work within FDOT Right of Way only.

All direction boring will be in accordance with FDOT Specification 555 latest edition.


Complete HDD Bore Log and submit upon completion.

No red, white or blue lights are permitted that may be construed as emergency response.

Julian Mckinley

SHEET INDEX

SHEET NO.	SHEET DESCRIPTION		
E - 1	KEY SHEET		
E - 2	TABULATION OF QUANTITIES		
E - 3	PROPOSED ONE-LINE DIAGRAM		
E - 4	SCHEMATIC PLAN VIEW		
E - 5	EXISTING TYPICAL SECTION		
E - 6	PROPOSED TYPICAL SECTION		
E - 7	FENCE LIGHTING DETAILS		
E - 8	MAIN DISCONNECT AND FEEDER DIAGRAM		
E - 9	EXISTING POWER/CABLE CONDUIT DIAGRAM		
E - 10	REVISED POWER/CABLE CONDUIT DIAGRAM		
E - 11	LIGHTING CONTROL DIAGRAM		
E - 12	LIGHTING CONTROL DETAILS		
E - 13	LIGHTING SCHEDULE (1 OF 4)		
E - 14	LIGHTING SCHEDULE (2 OF 4)		
E - 15	LIGHTING SCHEDULE (3 OF 4)		
E - 16	LIGHTING SCHEDULE (4 OF 4)		
E - 17	REPAIR SCHEDULE (1 OF 4)		
E - 18	REPAIR SCHEDULE (2 OF 4)		
E - 19	REPAIR SCHEDULE (3 OF 4)		
E - 20	REPAIR SCHEDULE (4 OF 4)		

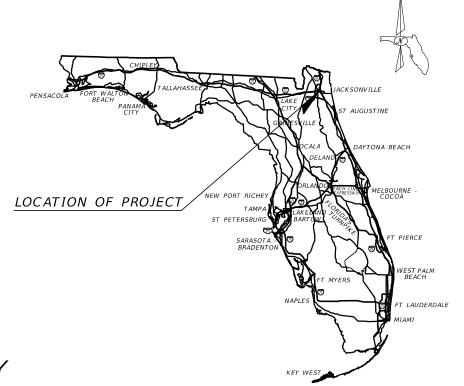

JACKSONVILLE TRANSPORTATION AUTHORITY



PROJECT #18-2
ACOSTA BRIDGE LED LIGHTING RETROFIT
PERMIT ISSUE
DECEMBER, 2019

10748 Deerwood Park Blvd. South Jacksonville, Florida 32256 904-256-2500 Certificate of Authorization No. EB0005620

LIGHTING PLANSENGINEER OF RECORD
APPROVAL RECOMMENDED BY:
APPROVED BY: JACKSONVILLE TRANSPORTATION AUTHORITY
APPROVED BY: FLORIDA DEPARTMENT OF TRANSPORTATION
ATTENTION IS DIRECTED TO THE FACT THAT THESE PLANS MAY HAVE BEEN REDUCED IN

SIZE BY REPRODUCTION. MUST BE CONSID-ERED WHEN OBTAINING SCALED DATA.


GOVERNING SPECIFICATIONS: STATE OF FLORIDA, DEPARTMENT OF TRANSPORTATION, STANDARD

DEPARTMENT OF TRANSPORTATION, STANDARD


SPECIFICATIONS, DATED 1994, SUPPLEMENTS AND

SPECIAL PROVISIONS THERETO IF NOTED IN THE

CONTRACT SPECIFICATIONS OF THIS PROJECT.

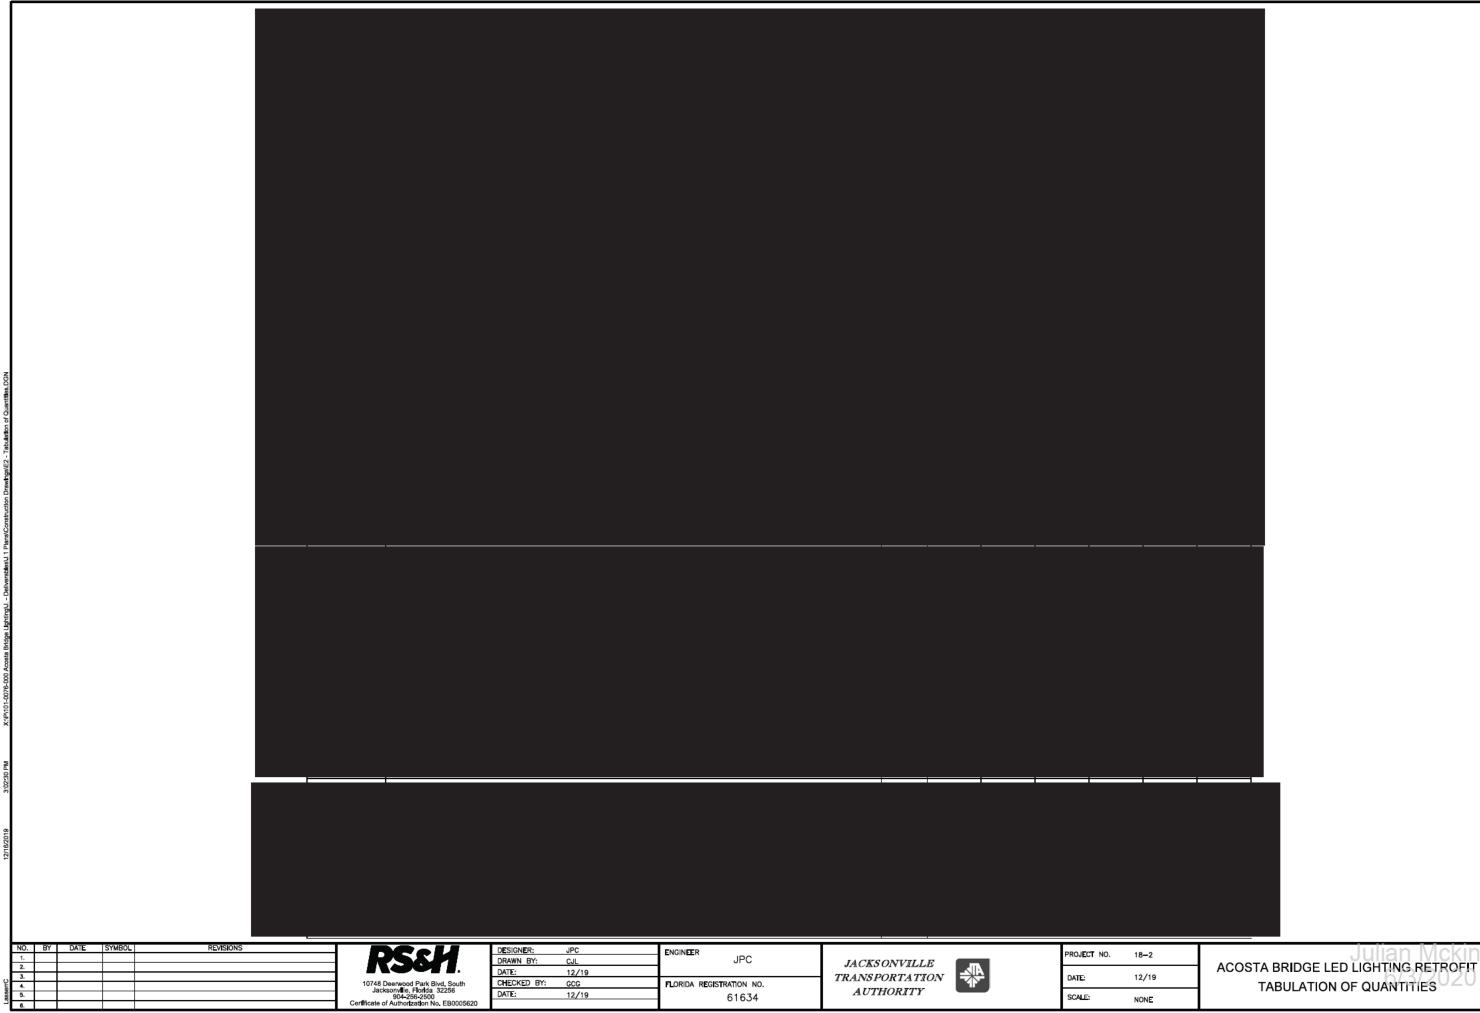

SHEET NO. DRAWING NO. E-2

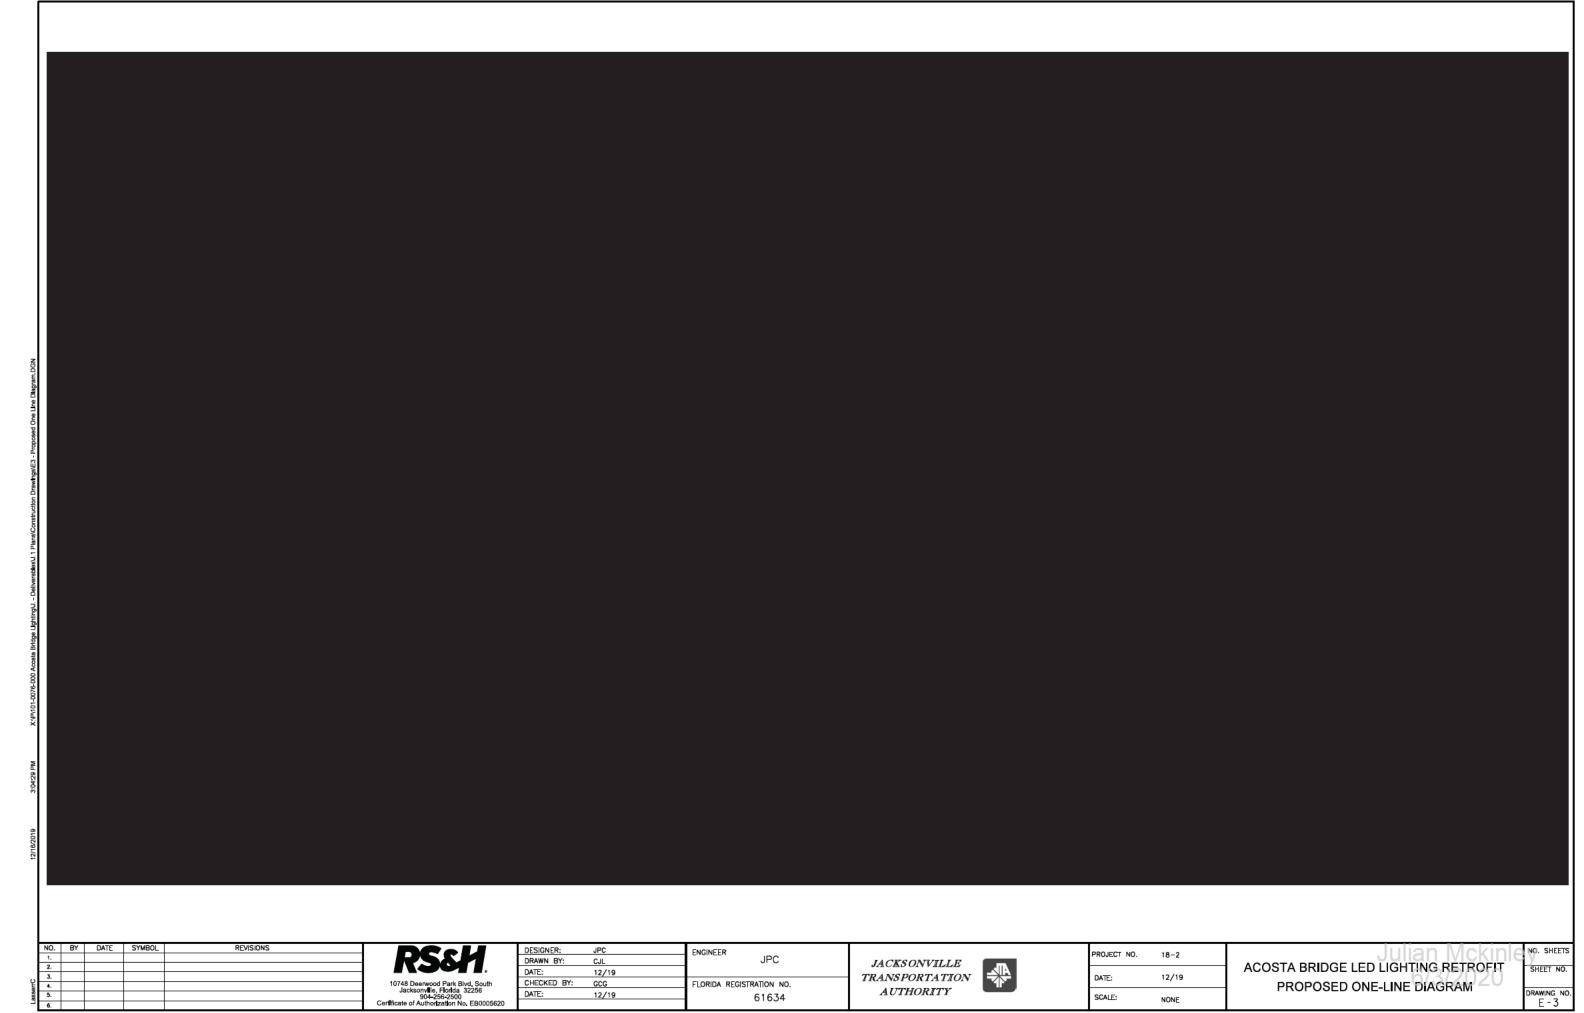



PROJECT NO.	18-2
DATE:	12/19
SCALE:	1" = 175'

ACOSTA BRIDGE LED LIGHTING RETROFIT
SCHEMATIC PLAN VIEW

SHEET NO.

DRAWING NO.
E - 4



NO. SHEETS

SHEET NO.

DRAWING NO. E-5

ACOSTA BRIDGE LED LIGHTING RETROFIT

EXISTING TYPICAL SECTION

REVISIONS

NO. BY DATE SYMBOL

DESIGNER: DRAWN BY: DATE: CHECKED BY:

JPC CJL 12/19

GCG

12/19

ENGINEER

JPC

61634

FLORIDA REGISTRATION NO.

JACKS ONVILLE TRANSPORTATION AUTHORITY PROJECT NO.


DATE:


SCALE:

18-2

12/19

NONE

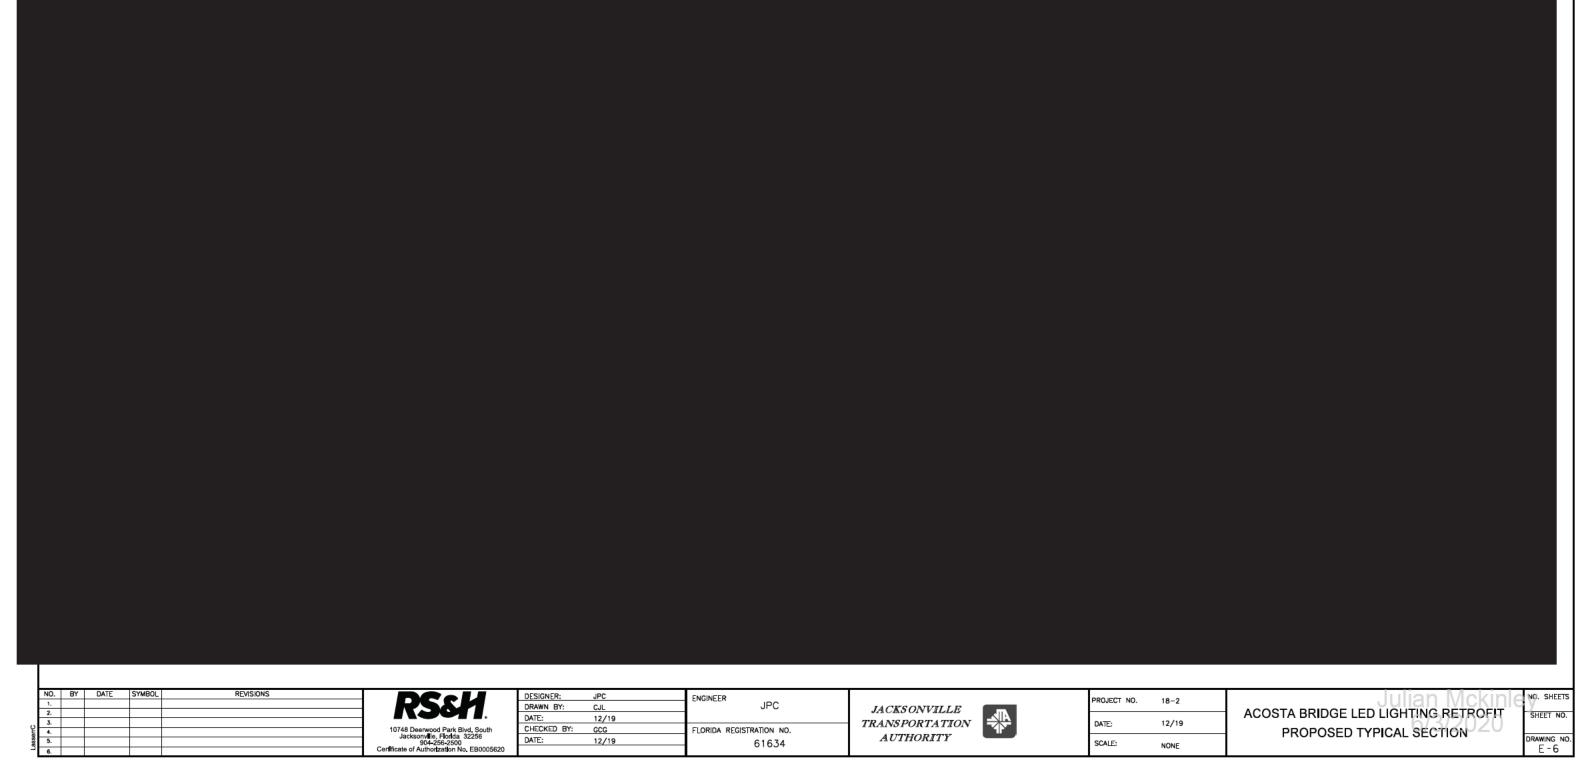

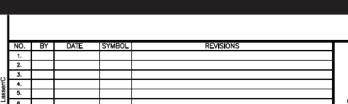

RSSH.

10748 Deerwood Park Blvd, South
Jacksonylle, Florida, 32256

 DESIGNER:
 JPC
 ENGINEER

 DRAWN BY:
 CJL
 CJL

 DATE:
 12/19
 CHECKED BY:
 GCG
 FLORIDA RI

 DATE:
 12/19
 FLORIDA RI
 FLORIDA RI

FLORIDA REGISTRATION NO.
61634



PROJECT NO.	18-2
DATE:	12/19
SCALE:	NONE

ACOSTA BRIDGE LED LIGHTING RETROFIT FENCE LIGHTING DETAILS

NO. SHEETS

SHEET NO.

DRAWING NO. E-7

SEQUENCE OF SCENE OPERATION:

- I. FULL LENGTH SCENES: THE INITIAL STATE OF THE CONTROLLER SHALL BE WITH THE LED LIGHTS OFF UNTIL A PRESET TIME EACH EVENING AT WHICH TIME, THE LED LIGHTS SHALL BE ILLUMINATED USING THE TYPICAL DAY SCENE THROUGHOUT UNTIL A SHUTTLE ENTERS EITHER END OF THE BRIDGE. THE SHUTTLE SENSOR SHALL SENSE THE PASSAGE OF THE VEHICLE AND TURN THE LED LIGHTS OFF ON THAT SIDE OF THE BRIDGE. AN ADJUSTABLE TIMING SYSTEM SHALL THEN TURN THE LIGHTING BACK ON IN 25' LONG SEGMENTS SO THAT THE LIGHT TRAIL CHASES THE SHUTTLE ACROSS THE BRIDGE, SHUTTLE TRAVEL IS 20MPH, WHEN THE SHUTTLE IS DETECTED BY THE SENSOR AS EXITING THE BRIDGE, THE LIGHTS WILL REMAIN ON UNTIL A SHUTTLE IS AGAIN DETECTED AS ENTERING THE BRIDGE. AS THE VEHICLE MAY OPERATE AS A SHUTTLE ON THE SAME TRACK, OR MAY CROSS OVER TO THE OTHER TRACK FOR THE RETURN CROSSING, THE CONTROLLER MUST BE ABLE TO RECOGNIZE THE DIRECTION THE VEHICLE IS TRAVELING AND CONTROL THE LIGHT SEGMENTS SO THAT THEY ALWAYS FOLLOW THE VEHICLE, FULL LENGTH SCENES INCLUDE TYPICAL DAY, BREAST CANCER AWARENESS, NEW YEARS DAY AND SAINT PATRICKS DAY.
- 2. ALTERNATING SCENES: THE INITIAL STATE OF THE CONTRO EACH EVENING AT WHICH TIME, THE LED LIGHTS SHALL BE SCENE, ALTERNATING IN 25 FOOT LONG SEGMENTS THROUGH CHRISTMAS, HALLOWEEN, THANKSGIVING, VALENTINES DAY

	NO.	BY	DATE	SYMBOL	REVISIONS
	1.				
	2.				
o	3.				
Æ	4.				
ass	5.				

Certificate of Authorization No. EB0005620

	DESIGNER:	JPC	ENGINEER	
	DRAWN BY:	CJL		JPC
	DATE:	12/19		
	CHECKED BY:	GCG	FLORIDA REGIS	TRATION NO.
	DATE:	12/19		61634
)				0.00+

JACKS ONVILLE TRANSPORTATION AUTHORITY



PROJECT NO. 18-2 12/19 NONE

ACOSTA BRIDGE LED LIGHTING RETROFIT MAIN DISCONNECT AND FEEDER DIAGRAM

NO. SHEETS

SHEET NO. RAWING NO E-8

	DESIGNED.	IBC		
AND EA	SIEK.			
		ALTERNA	TING SOLNES INCLUDE I'AI	
HOUT TH	F BRIDGE S	PANS. ALTERNA	ATING SCENES INCLUDE PAT	RIOTIC.
			S OF THE PATRICULAR ALTE	
			IGHTS OFF UNTIL A PRESET	

I. PATRIOTIC: RED, WHITE, AND BLUE IN ALTERNATING 25' SEGMENTS

- 2. CHRISTMAS: RED AND GREEN IN 25' ALTERNATING
- SEGMENTS

I. EXISTING METER AND DISCONNECT SWITCH LOCATED

2. CONTRACTOR SHALL OBTAIN A UTILITY LOCATION BEFORE ANY DIGGING. USE EXTREME CAUTION WHEN DIGGING DUE TO EXISTING UNDERGROUND

I. TYPICAL DAY: JAGUAR TEAL THROUGHOUT WITH

3. NEW YEARS: GOLD (AMBER) THROUGHOUT WITH

4. ST. PATRICKS DAY: GREEN THROUGHOUT WITH

2. BREAST CANCER AWARENESS: PINK THROUGHOUT WITH

ADJACENT TO TRANSFORMER.

FULL LENGTH SCENE SELECTIONS:

AUTOMATIC SHUTTLE TRACKING


AUTOMATIC SHUTTLE TRACKING

AUTOMATIC SHUTTLE TRACKING

AUTOMATIC SHUTTLE TRACKING


ALTERNATING SCENE SELECTIONS

- 3. HALLOWEEN: ORANGE AND BLACK IN 25' ALTERNATING SECTIONS
- 4. THANKSGIVING: ORANGE AND BLACK IN 25' ALTERNATING SECTIONS
- 5. VALENTINES DAY: RED AND PINK IN 25' ALTERNATING SEGMENTS
- 6. EASTER: PURPLE, YELLOW, GREEN, AND PINK IN 25' ALTERNATING SEGMENTS

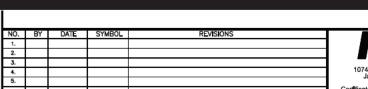



	DESIGNER:	JPC	ENGINEER
	DRAWN BY:	CJL	
	DATE:	12/19	
	CHECKED BY:	GCG	FLORIDA RE
	DATE:	12/19	
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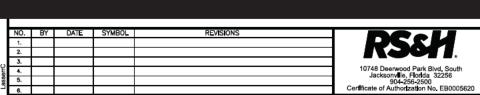


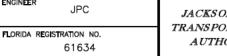PROJECT NO.	18-2
DATE:	12/19
SCALE:	NONE

ACOSTA BRIDGE LED LIGHTING RETROFIT EXISTING POWER/CABLE CONDUIT DIAGRAM


SHEET NO.

DRAWING NO.
E - 9



	DESIGNER:	JPC	ENG
	DRAWN BY:	CJL	
	DATE:	12/19	
	CHECKED BY:	GCG	FLC
	DATE:	12/19	
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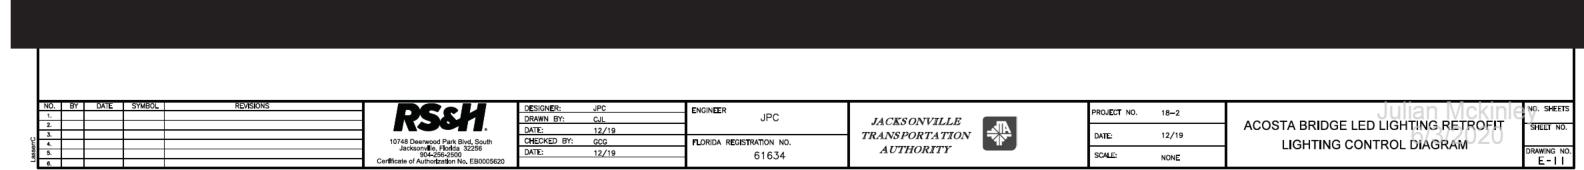
FLORIDA REGISTRATION NO. 61634

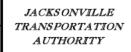

PROJECT NO.	18-2
DATE:	12/19
SCALE:	NONE

ACOSTA BRIDGE LED LIGHTING RETROFIT
PROPOSED POWER/CABLE CONDUIT DIAGRAN


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SCALE:

NONE

12/19




10748 Deerwood Park Blvd, South Jacksonville, Flortda 32256 904-256-2500 Certificate of Authorization No. EB0005620

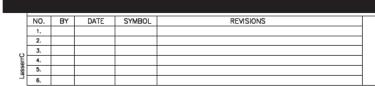DESIGNER:	JPC	ENGINEER	
DRAWN BY:	CJL	JPC	
DATE:	12/19		
CHECKED BY:	GCG	FLORIDA REGISTRATION NO.	
DATE:	12/19	61634	
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PROJECT NO.	18-2
DATE:	12/19
SCALE:	NONE

ACOSTA BRIDGE LED LIGHTING RETROFIT LIGHTING CONTROL DETAILS



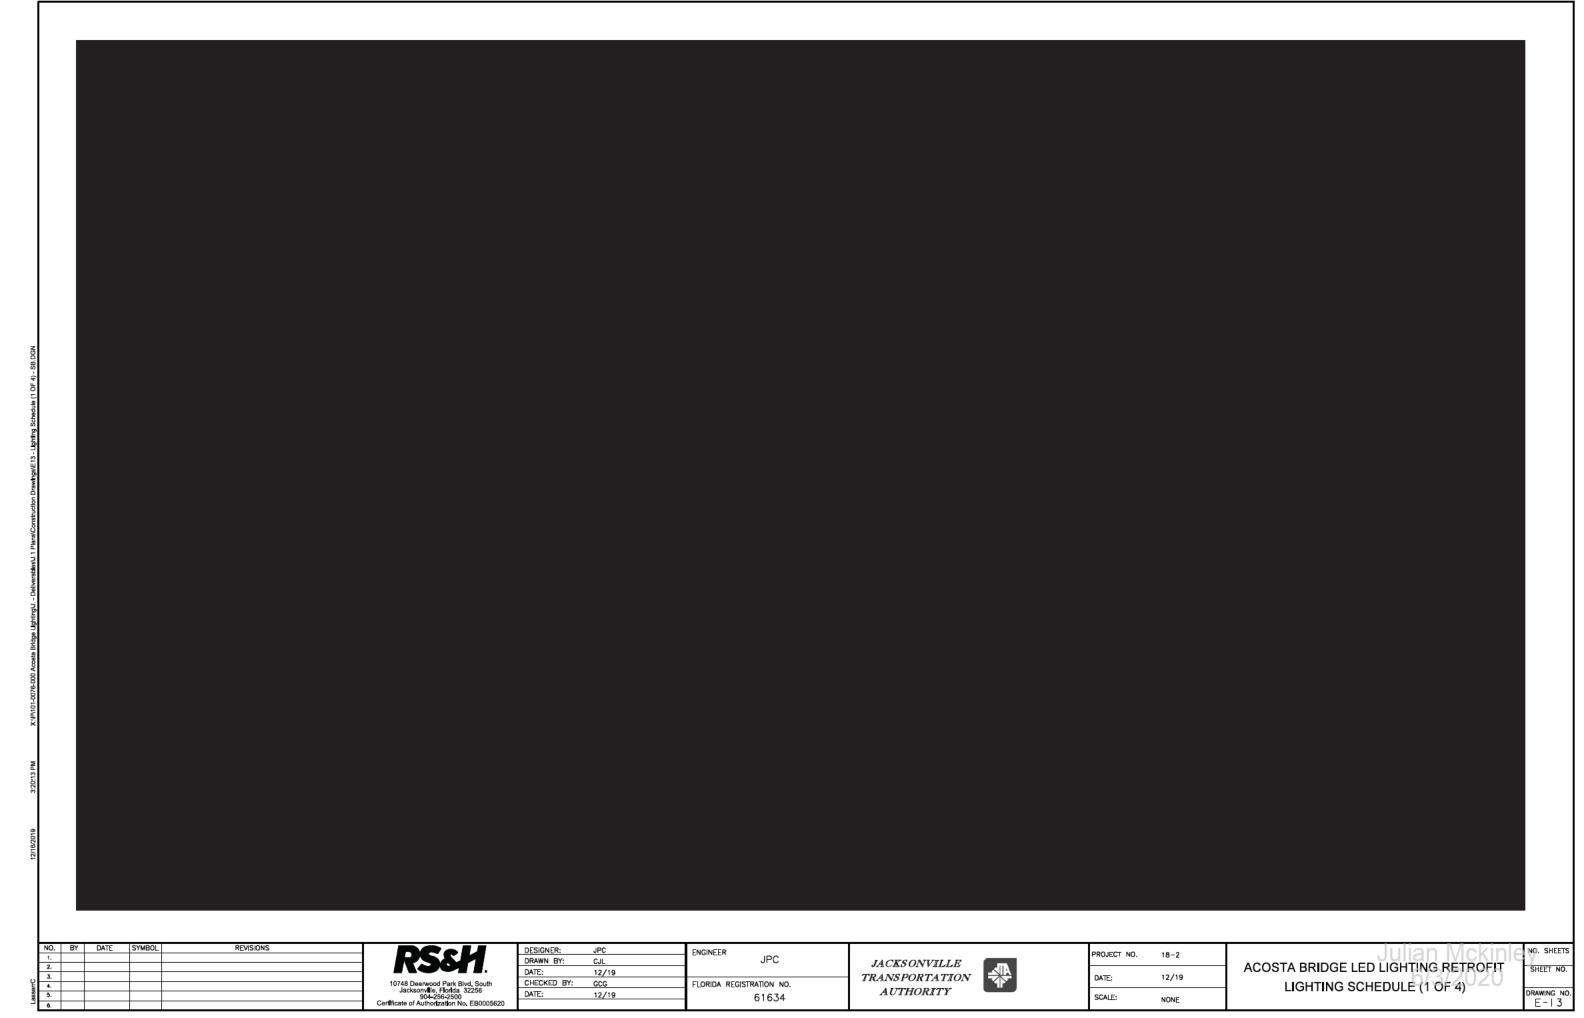

10748 Deerwood Park Blvd, South Jacksonville, Florida 32256 904-256-2500 Certificate of Authorization No. EB0005620

JPC CJL 12/19 DATE: CHECKED BY: GCG 12/19

FLORIDA REGISTRATION NO. 61634

JACKS ONVILLE TRANSPORTATION AUTHORITY

PROJECT NO.	18-2
DATE:	12/19
SCALE:	NONE

LIGHTING SCHEDULE (2 OF 4)



ESIGNER: JPC		ENGINEER
RAWN BY:	CJL	JPC
ATE;	12/19	
HECKED BY:	GCG	FLORIDA REGISTRATION NO.
ATE:	12/19	61634
		01057

JACKSONVILLE TRANSPORTATION AUTHORITY



PROJECT NO.	18-2
DATE:	12/19
SCALE:	NONE

LIGHTING SCHEDULE (3 OF 4)

SHEET NO. DRAWING NO. E-15



REVISIONS




DESIGNER:	JPC	ENGINEER
DRAWN BY:	CJL	JPC
DATE:	12/19	
CHECKED BY:	GCG	FLORIDA REGISTRATION NO.
DATE:	12/19	61634
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JACKSONVILLE
TRANSPORTATION
AUTHORITY

	PROJ
<u>}</u>	DATE
	SCAL

PROJECT NO.	18-2
DATE:	12/19
SCALE:	NONE

ACOSTA BRIDGE LED LIGHTING RETROFIT LIGHTING SCHEDULE (4 OF 4)



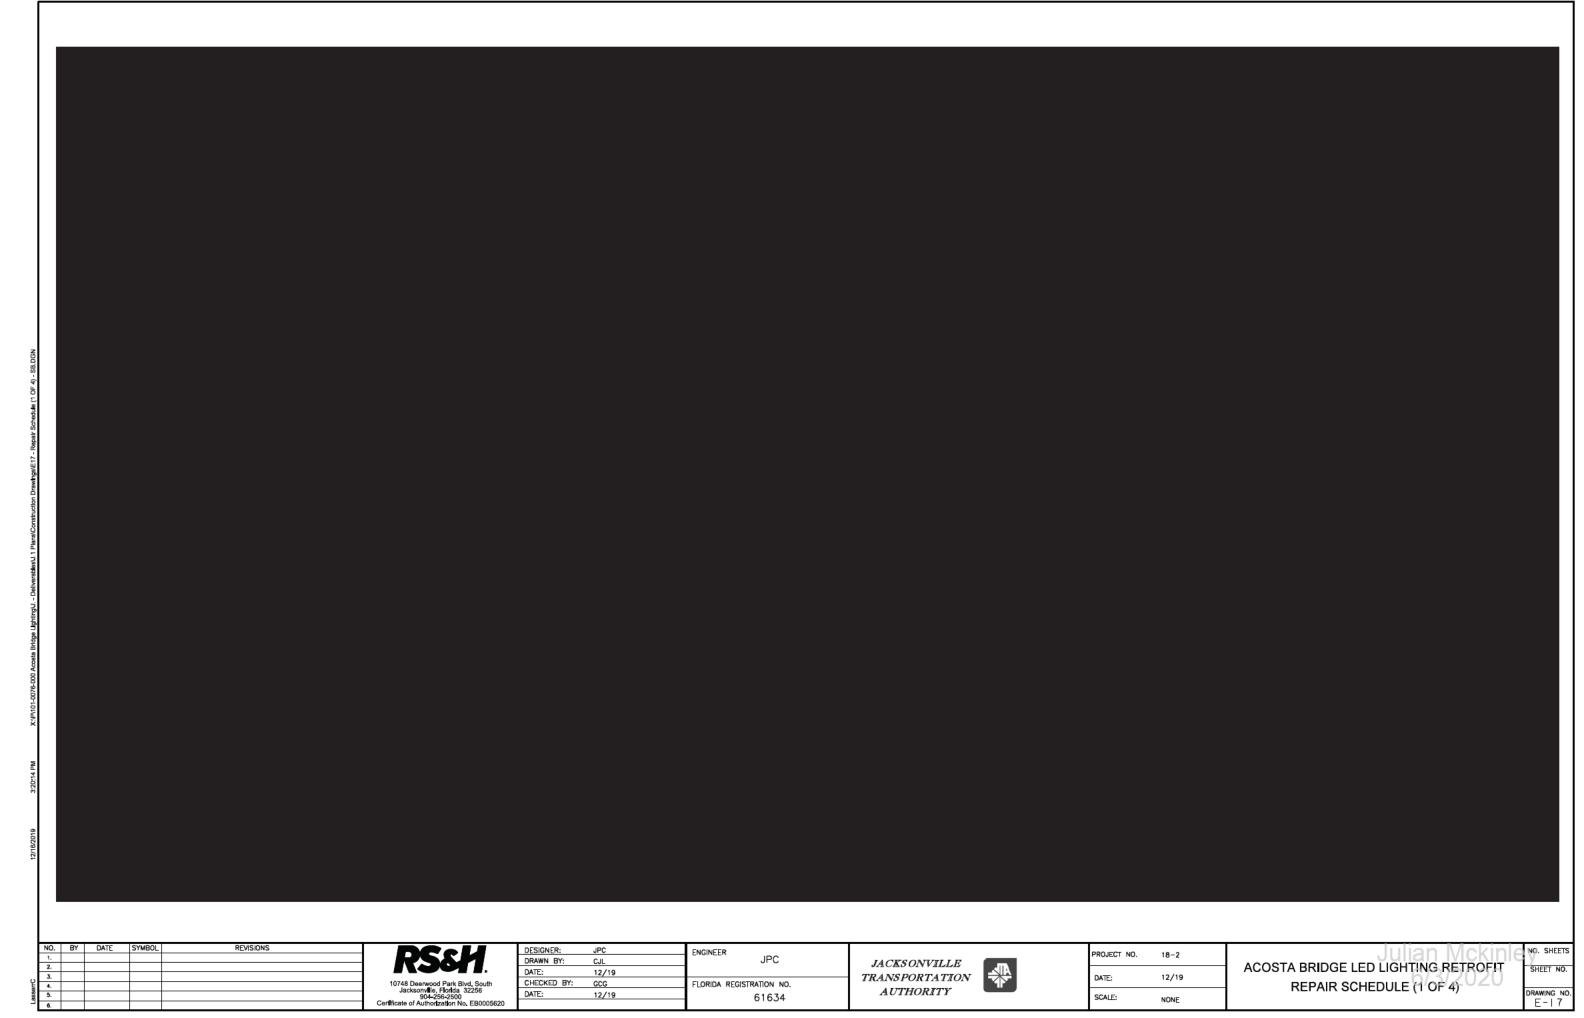

10748 Deenwood Park Blvd, South Jacksonville, Florida 32256 904-256-2500 Certificate of Authorization No. EB0005620

DESIGNER:	JPC	ENGINE
DRAWN BY:	CJL	
DATE:	12/19	
CHECKED BY:	GCG	FLORID
DATE:	12/19	


DRIDA REGISTRATION NO.
61634

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PROJECT NO.	18-2
DATE:	12/19
SCALE:	NONE

ACOSTA BRIDGE LED LIGHTING RETROFIT REPAIR SCHEDULE (2 OF 4)



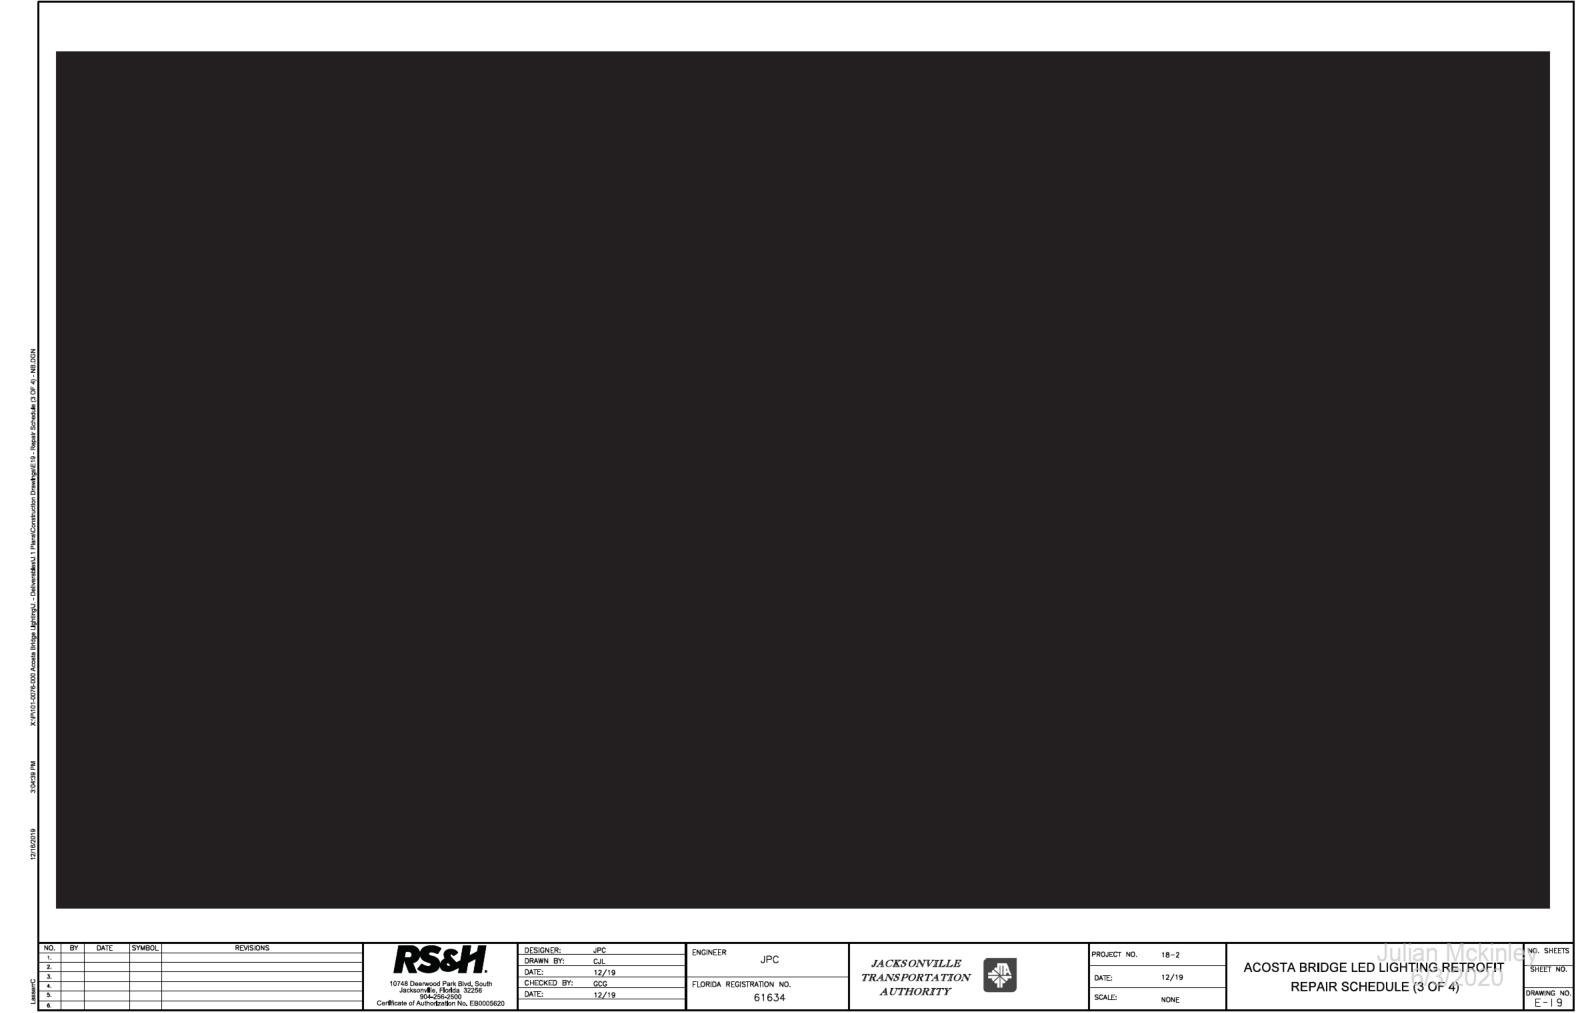

10748 Deerwood Park Bivd, South Jacksonville, Florida 32256 904-256-2500 Certificate of Authorization No. EB0005620

FLORIDA REGISTRATION NO. 61634

JACKS ONVILLE TRANS PORTATION AUTHORITY PROJECT NO. 18-2


DATE: 12/19

SCALE: NONE

ACOSTA BRIDGE LED LIGHTING RETROFIT REPAIR SCHEDULE (4 OF 4)



REVISION 11/01/17

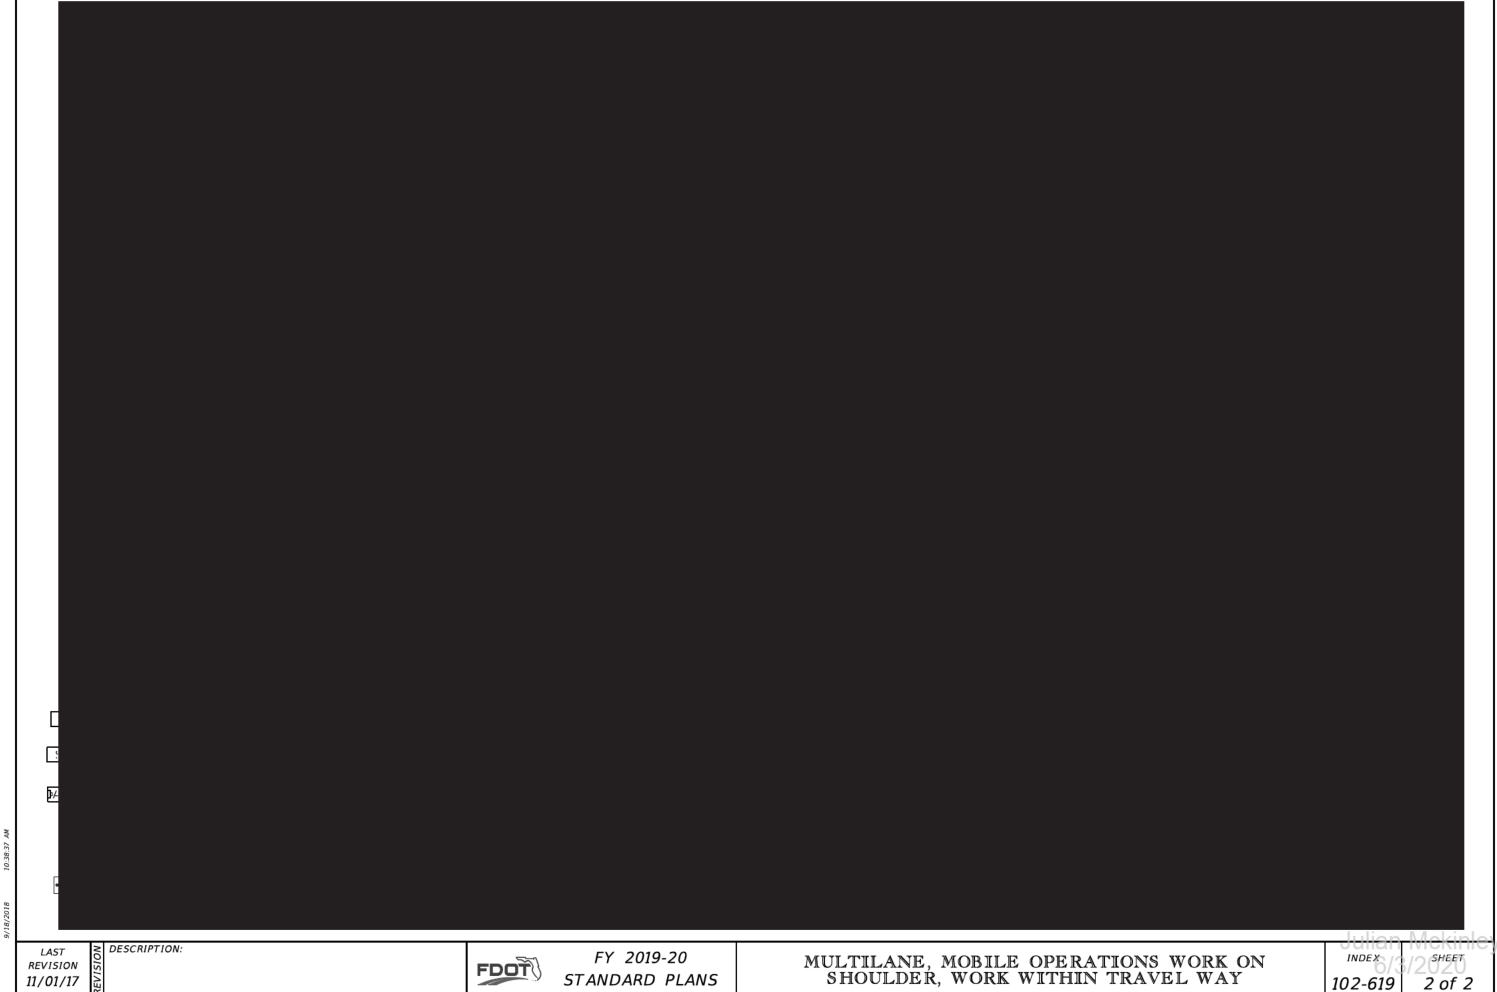

Redactions made to this document are in keeping with the removal of safety sensitive information as allowed in Florida Statute 119.071 (3).